


1 FIRST FLOOR
TECHNOLOGY OVERALL
ADMIN
1/8" = 1'-0"

HILLIARD ARCHITECTS INC. COPYRIGHT

[illegible]

CONSULTANTS:

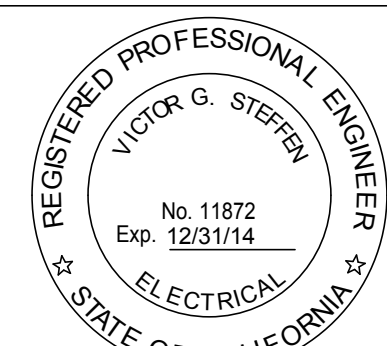

ARCHITECT/ENGINEERS:



HILLIARD ARCHITECTS, INC
251 Post Street, Suite 620
San Francisco, CA 94108-5017
Tel 415 989 6400, Fax 415 989 3056
www.HilliardArchitects.com

Drawing Title

**TECHNOLOGY OVERALL FLOOR
PLAN**

Approved: Project Director

Project Title	VA PA BLDG 6 ADMINISTRATIVE EXPANSION
---------------	--

Location	VAPAHCS, PALO ALTO CAMPUS 3801 MIRANDA AVE. PALO ALTO, CA 94304
----------	--

☐ Checked

Drawn

Project Number
640-13-121PBuilding Number
6Drawing Number
T1.00A


Drug of

Office of
Construction
and Facilities
Management

Department of
Veterans Affairs



VA FORM 08-6231

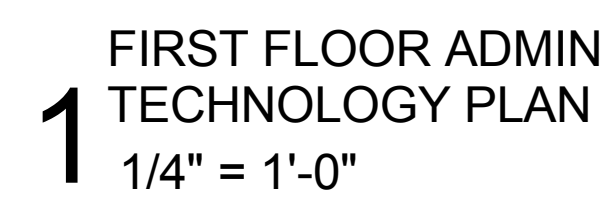 Department of
Veterans Affairs

FINAL BID DOCUMENTS




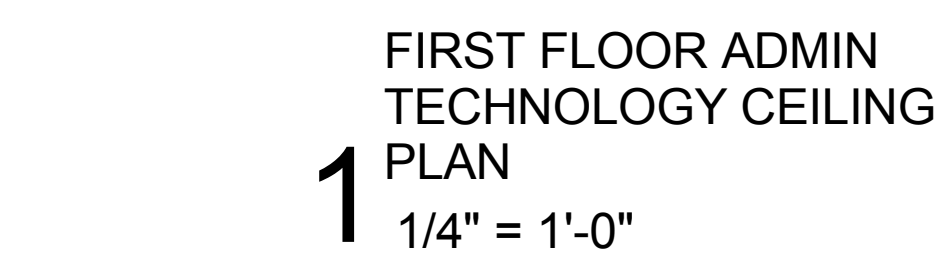


Figure 10: The 16 possible configurations of the 16 nodes of the 2×8 grid. The configurations are labeled with the number of nodes in each of the four quadrants (top-left, top-right, bottom-left, bottom-right) in the order: top-left, top-right, bottom-left, bottom-right. The configurations are: (0,0,0,0), (0,0,0,1), (0,0,1,0), (0,0,1,1), (0,1,0,0), (0,1,0,1), (0,1,1,0), (0,1,1,1), (1,0,0,0), (1,0,0,1), (1,0,1,0), (1,0,1,1), (1,1,0,0), (1,1,0,1), (1,1,1,0), (1,1,1,1). The configurations are shown as a grid of 16 nodes, with the top-left node being the origin (0,0). The configurations are labeled with the number of nodes in each of the four quadrants (top-left, top-right, bottom-left, bottom-right) in the order: top-left, top-right, bottom-left, bottom-right. The configurations are: (0,0,0,0), (0,0,0,1), (0,0,1,0), (0,0,1,1), (0,1,0,0), (0,1,0,1), (0,1,1,0), (0,1,1,1), (1,0,0,0), (1,0,0,1), (1,0,1,0), (1,0,1,1), (1,1,0,0), (1,1,0,1), (1,1,1,0), (1,1,1,1).

Office of
Construction
and Facilities
Management

[illegible]

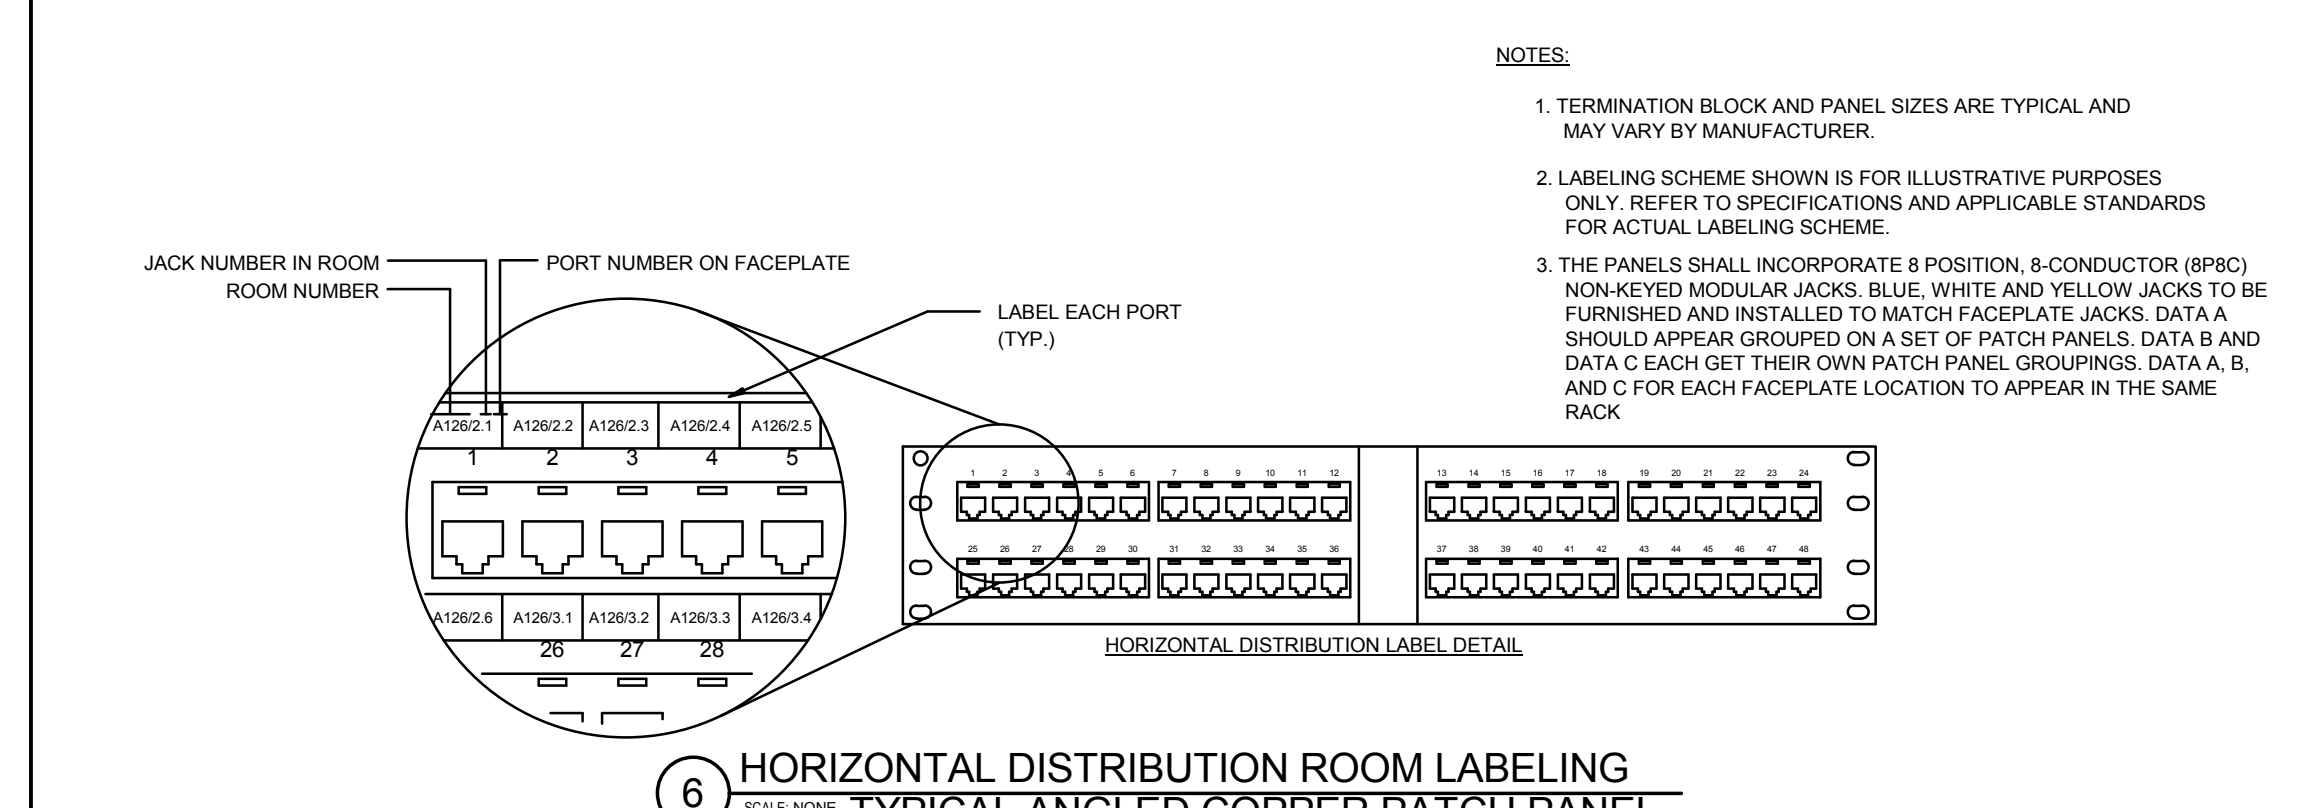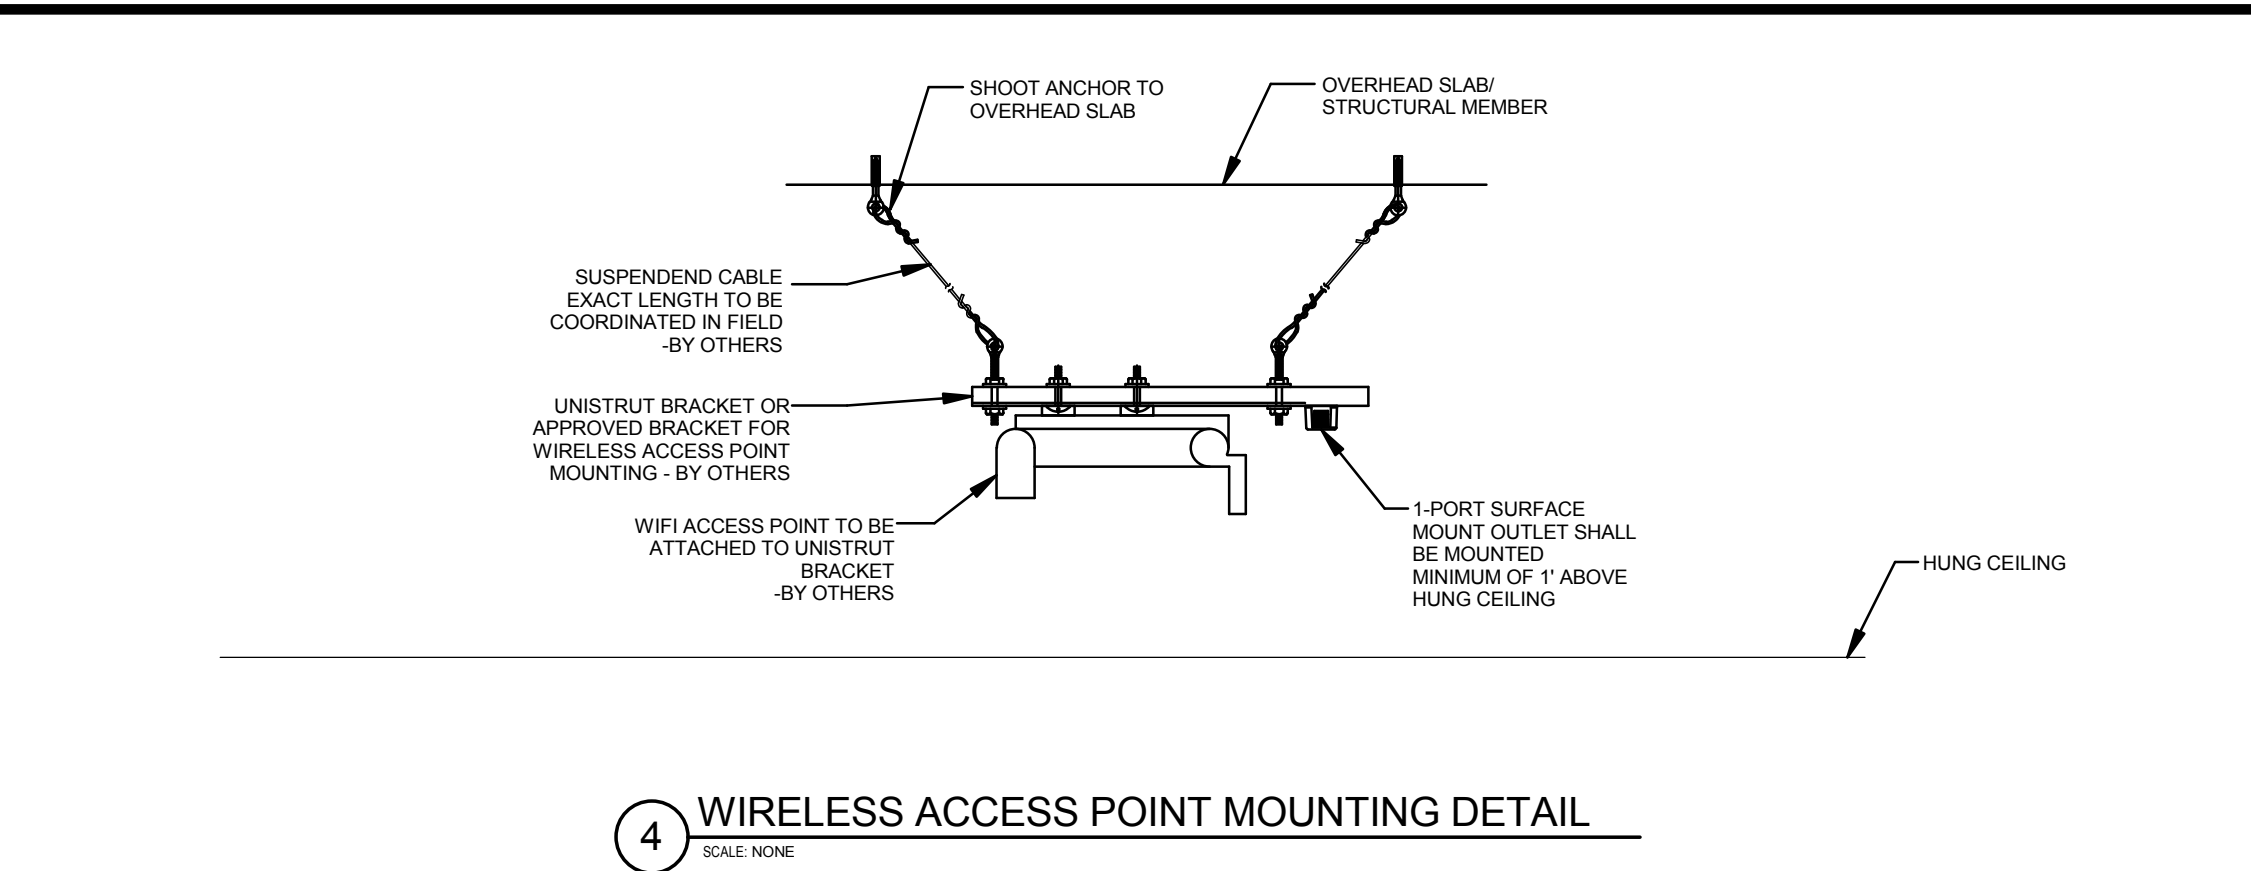

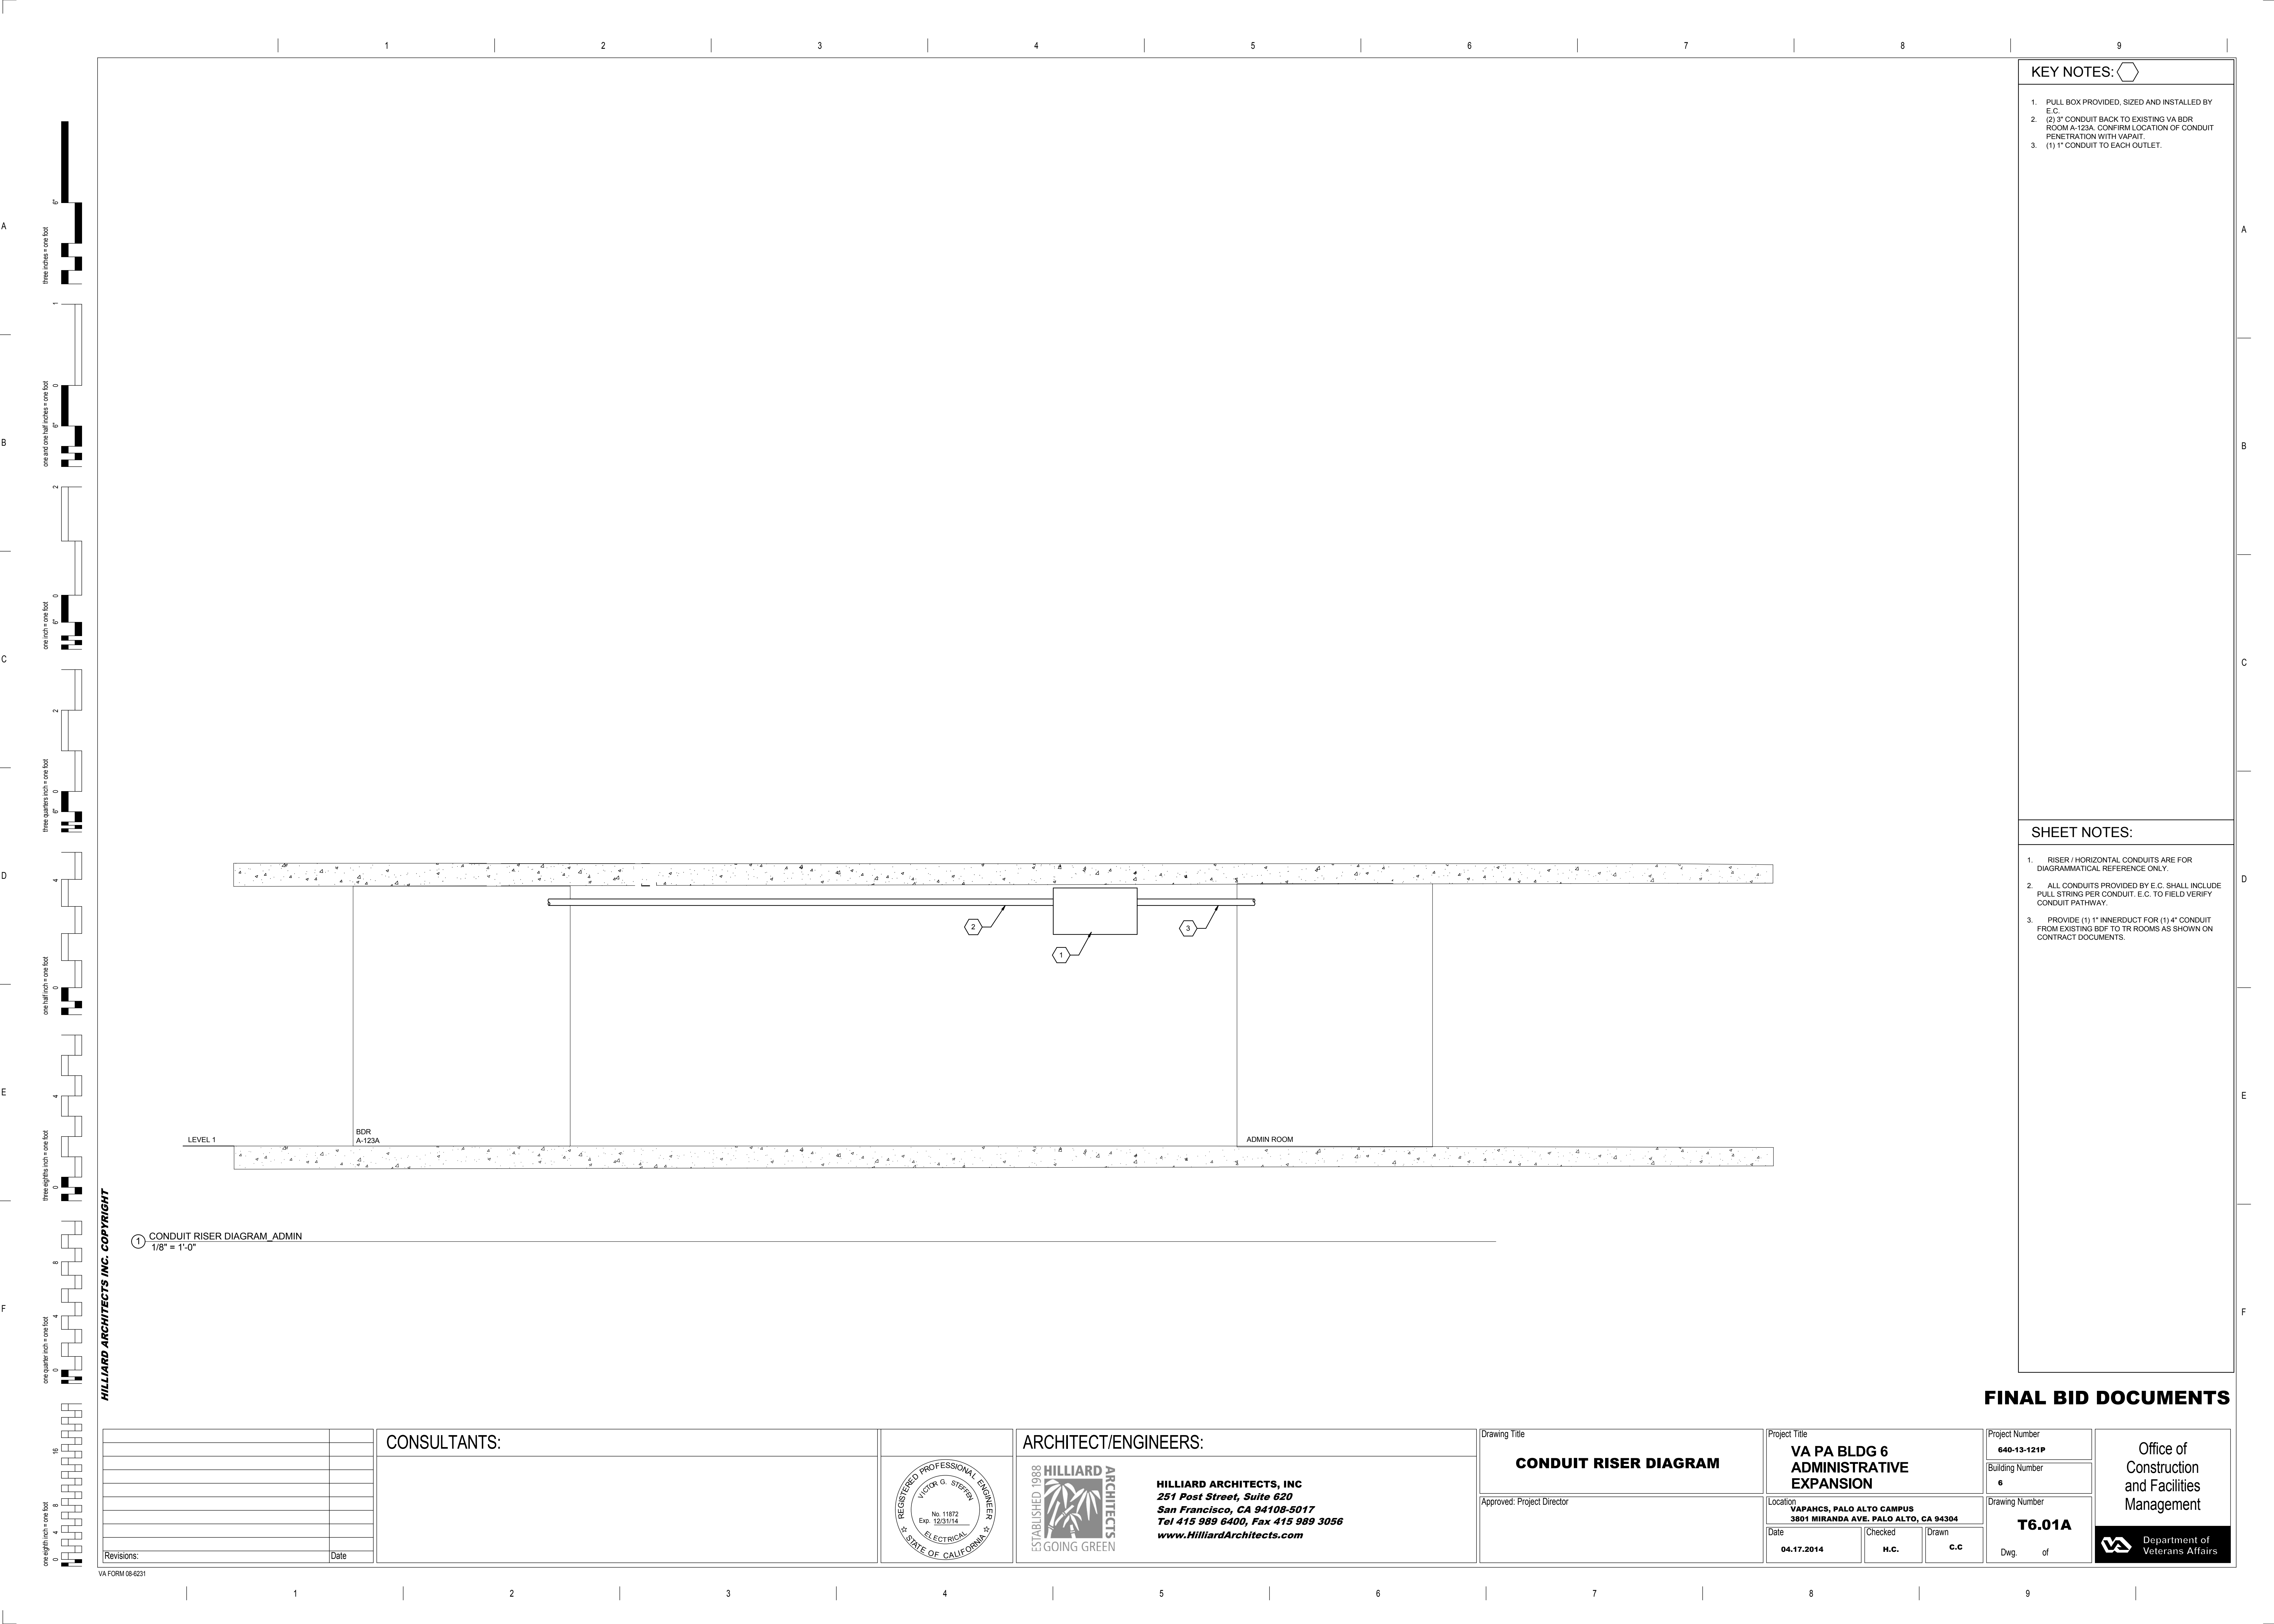

A

B

C

D

E

F

A

B

C

D

E

F

three holes = one foot
6"

one and one half holes = one foot
6"

one inch = one foot
6"

three quarters inch = one foot
6"

one half inch = one foot
6"


three eighths inch = one foot
6"

one quarter inch = one foot
6"

one eighth inch = one foot
6"

HILLIARD ARCHITECTS INC. COPYRIGHT

1 COPPER SINGLE LINE DIAGRAM_ADMIN
1/8" = 1'-0"

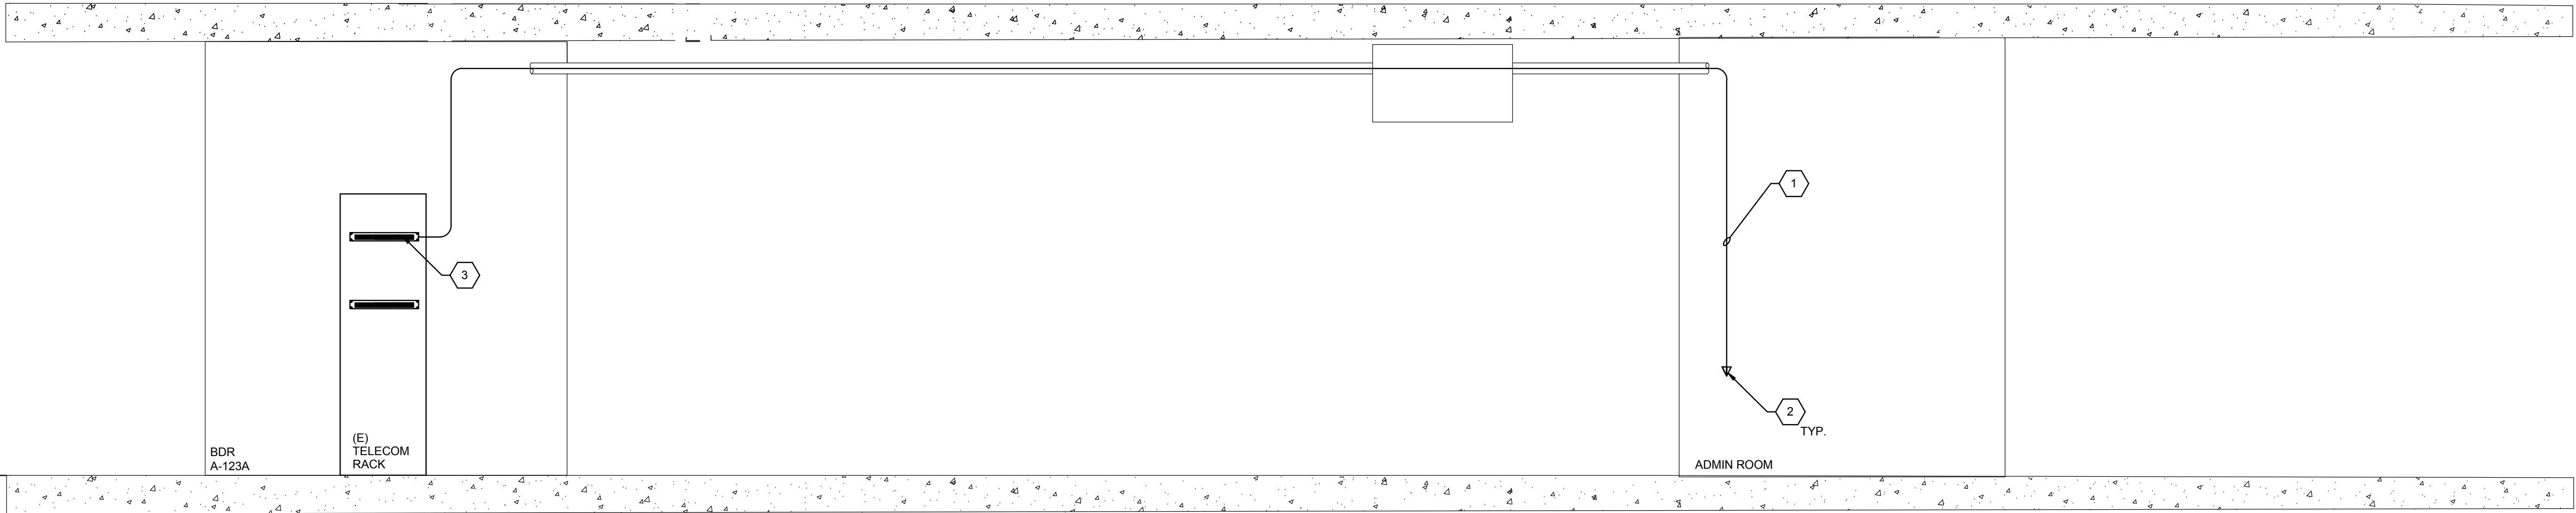

KEY NOTES:

- (6) CAT 6 UTP TO WORK AREA OUTLETS. TYPICAL.
- WORK AREA OUTLETS. TYPICAL.
- CAT6 48 PORT PATCH PANEL.

SHEET NOTES:

- COORDINATE WITH VA O&T FOR TERMINATION OF CABLING WITHIN ROOM BDR A-123A.

FINAL BID DOCUMENTS

		CONSULTANTS:				ARCHITECT/ENGINEERS:		Drawing Title COPPER SINGLE LINE DIAGRAM		Project Title VA PA BLDG 6 ADMINISTRATIVE EXPANSION		Project Number 640-13-121P		 Office of Construction and Facilities Management Department of Veterans Affairs	
								Approved: Project Director		Location VAPAHCs, PALO ALTO CAMPUS 3801 MIRANDA AVE. PALO ALTO, CA 94304		Building Number 6			
Revisions:		Date								Date 04.17.2014		Checked H.C.			
												Drawing Number T6.02A		Dwg. of	